

Scope:

DEPARTMENT OF REGULATORY AND ECONOMIC RESOURCES (RER) BOARD AND CODE ADMINISTRATION DIVISION

NOTICE OF ACCEPTANCE (NOA)

PRODUCT CONTROL SECTION 11805 SW 26 Street, Room 208 Miami, Florida 33175-2474 T (786) 315-2590 F (786) 315-2599

www.miamidade.gov/economy

MIAMI-DADE COUNTY

Gensteel Doors Inc. 4950 Hickmore Street Ville St. Laurent, Quebec, Canada H4T1K6

This NOA is being issued under the applicable rules and regulations governing the use of construction materials. The documentation submitted has been reviewed and accepted by Miami-Dade County RER -Product Control Section to be used in Miami Dade County and other areas where allowed by the Authority Having Jurisdiction (AHJ).

This NOA shall not be valid after the expiration date stated below. The Miami-Dade County Product Control Section (In Miami Dade County) and/or the AHJ (in areas other than Miami Dade County) reserve the right to have this product or material tested for quality assurance purposes. If this product or material fails to perform in the accepted manner, the manufacturer will incur the expense of such testing and the AHJ may immediately revoke, modify, or suspend the use of such product or material within their jurisdiction. RER reserves the right to revoke this acceptance, if it is determined by Miami-Dade County Product Control Section that this product or material fails to meet the requirements of the applicable building code.

This product is approved as described herein, and has been designed to comply with the Florida Building Code, including the High Velocity Hurricane Zone.

DESCRIPTION: Series "GenStorm 4888 HD" Flush Outswing Single & Double Steel Doors-LMI

APPROVAL DOCUMENT: Drawing No. **AD15-35**, titled "Genstorm Outswing 4888 HD Steel Door System (LMI)", sheet 1 through 12 of 12, dated 12/14/14 and last revised on FEB 27, 2018, prepared by MCY Engineering, Inc., signed and sealed by Yiping Wang, P.E., bearing the Miami-Dade County Product Control revision stamp with the Notice of Acceptance number and expiration date by the Miami-Dade County Product Control Section.

MISSILE IMPACT RATING: Large and Small Missile Impact Resistant Limitations:

- 1. Doors are rated for water infiltration requirement w/ threshold (w/ item #18, bulb gasket & cell foam tape entire frame perimeter). All door panels require Stiffeners (items #20, #21& #22), see sheet 8 for details.
- 2. Lock Options # 1, 2 & 4 in sheet 9, require total two (2) flush bolts (top/bottom) on the Inactive panel. Dorma 9400 series Surface Vertical Rod & Dorex 9500 FV must use the corresponding strikes at rod ends.

LABELING: Each unit shall bear one of the following permanent labels:

Gensteel Doors Inc.

Gensteel Doors Inc.

4950 Hickmore Street

Ville St. Laurent, Quebec, Canada H4T1K6

Cornwall, Ontario, Canada K6H7M4

and series and the statement: "Miami-Dade County Product Control Approved".

North American Doors Corp.

1471 Military Turnpike

Plattsburgh, NY 12901-1911

RENEWAL of this NOA shall be considered after a renewal application has been filed and there has been no change in the applicable building code negatively affecting the performance of this product.

TERMINATION of this NOA will occur after the expiration date or if there has been a revision or change in the materials, use, and/or manufacture of the product or process. Misuse of this NOA as an endorsement of any product, for sales, advertising or any other purposes shall automatically terminate this NOA. Failure to comply with any section of this NOA shall be cause for termination and removal of NOA.

ADVERTISEMENT: The NOA number preceded by the words Miami-Dade County, Florida, and followed by the expiration date may be displayed in advertising literature. If any portion of the NOA is displayed, then it shall be done in its entirety.

INSPECTION: A copy of this entire NOA shall be provided to the user by the manufacturer or its distributors and shall be available for inspection at the job site at the request of the Building Official.

This NOA revises # 15-0526.02 consists of this page 1 and evidence pages E-1 and E-2, as well as approval document mentioned above.

The submitted documentation was reviewed by Ishaq I. Chanda, P.E.



NOA No. 18-0116.16 Expiration Date: April 21, 2021 Approval Date: March 06, 2018 Page 1

NOTICE OF ACCEPTANCE: EVIDENCE SUBMITTED

1. Evidence submitted under previous files

A. DRAWINGS

- 1. Manufacturer's die drawings and sections
- 2. Drawing No. **AD15-35**, titled "Genstorm Outswing 4888 HD Steel Door System (LMI)", sheet 1 through 12 of 12, dated MAR 25, 2016, prepared by MCY Engineering, Inc., signed and sealed by Yiping Wang, P.E.

B. TESTS

- 1. Test reports on 1) Air Infiltration Test, per FBC, TAS 202-94
 - 2) Uniform Static Air Pressure Test, Loading per FBC, TAS 202-94
 - 3) Water Resistance Test, per FBC, TAS 202-94(see approval limitations)
 - 4) Large Missile Impact Test per FBC, TAS 201-94
 - 5) Cyclic Wind Pressure Loading per FBC, TAS 203-94
 - 6) Forced Entry Test, per FBC 2411 3.2.1 and TAS 202-94

Along with marked-up drawings and installation diagram of Genstorm Opaque Outswing Double Doors, prepared by Fenestration Testing Laboratory, Inc., Test Report No. **FTL 7654**, dated 10/13/09 and **FTL 5898**, dated 08/14/2014, signed and sealed by Idalmis Ortega, P.E. Note: This test report has been revised by an addendum letter dated August 31, 2015, issued by fenestration Testing Lab, signed by Ms. Illiana Sanchez.

C. CALCULATIONS

1. Anchor verification calculations and structural analysis, complying with FBC-2014 (5th **Edition**), prepared by MCY Engineering, Inc., dated 05/18/15 and last revised on 11/11/15, signed and sealed by Yiping Wang, P.E.

D. QUALITY ASSURANCE

1. Miami Dade Department of Regulatory and Economic Resources (RER).

E. MATERIAL CERTIFICATIONS

- 1. Tensile test report N0. FTL 7654 per ASTM A370-05 dated 08/14/14, issued by Fenestration Testing Lab, signed and sealed by Idalmis Ortega, P.E.
- 2. Notice of Acceptance No. **14-1015.08** issued to Johns Manville for "Polyisocyanurate foam(R-panel 25PSI)", expiring on 02/05/19.
- 3. Technical specification of Fiberglass 800 series insulation compliance to ASTME-84, published by Johns Manville dated 06/15.
- 4. Technical specification of "Expanded Polystyrene (EPS-type I)" sheet, published by LigerLite (using STYROCHEM's EPS beads)

F. STATEMENTS

- 1. Statement letter of conformance to FBC 2014 (5th Edition), dated 05/18/15, prepared by MCY Engineering, Inc, signed and sealed by Yiping Wang, P.E.
- 2. Statement letter dated March 30, 2016, for use of STYROCHEM's EPS beads to manufacturer LegerLite core, issued by Le Groupe LegerLite Inc, signed by Patrik L'Ecuyer, VP-Ventes.
- 3. Statement letter of Lab. Compliance, as a part of above test reports.

G. OTHER

1. Distribution agreement between GenSteel Door, Canada & North American Door Corp, N.Y. dated 10/22/10, signed by Bruno Gervasi and Antonio Gervasi, respectively.

Ishaq I. Chanda, P.E.
Product Control Examiner
NOA No. 18-0116.16
Expiration Date: April 21, 2021

Approval Date: March 06, 2018

NOTICE OF ACCEPTANCE: EVIDENCE SUBMITTED

2. New Evidence submitted

A. DRAWINGS

1. Drawing No. **AD15-35**, titled "Genstorm Outswing 4888 HD Steel Door System (LMI)", sheet 1 through 12 of 12, dated 12/14/14 and last revised on FEB 27, 2018, prepared by MCY Engineering, Inc., signed and sealed by Yiping Wang, P.E.

B. Test

1. None.

C. CALCULATIONS

1. None.

D. QUALITY ASSURANCE

1. Miami Dade Department of Regulatory and Economic Resources (RER).

E. MATERIAL CERTIFICATIONS

1. None.

F. STATEMENTS

- 1. Statement letter of conformance to FBC 2017 (6th Edition), dated 01/02/18, prepared by MCY Engineering, Inc., signed and sealed by Yiping Wang, P.E.
- 2. E-mail statement letter dated 02/27/18 clarifying DWG changes, issued by MCY Engineering, Inc., signed by Yanet Pablos.

G. OTHER

1. This NOA revises # 15-0526.02, expiring 04/21/21.

Shaq . Chanda BI

Ishaq I. Chanda, P.E.
Product Control Examiner
NOA No. 18-0116.16
Expiration Date: April 21, 2021
Approval Date: March 06, 2018

GENSTEEL DOORS INC. SERIES "GENSTORM OUTSWING 4888 HEAVY DUTY OPAQUE STEEL DOOR" LARGE MISSILE IMPACT (LMI & SMI)

SERIES GENSTORM OUTSWING 4888 HEAVY DUTY OPAQUE STEEL DOOR (LMI & SMI) TYPICAL ANCHORS @ JAMB: (REFER TO ELEVATION FOR SPACING)

- THIS PRODUCT HAS BEEN DESIGNED AND TESTED TO COMPLY WITH THE REQUIREMENTS OF THE 6TH EDITION OF FLORIDA BUILDING CODE 2017 INCLUDING HIGH VELOCITY HURRICANE ZONE (HVHZ).
- DOORS RATED FOR LARGE AND SMALL MISSILE IMPACT AND DO NOT REQUIRE
- DOORS APPROVED FOR INSTALLATIONS WHERE WATER INFILTRATION RESISTANCE IS REQUIRED (SINGLE ROW SELF-ADHESIVE CLOSED CELL FOAM TAPE TO BE APPLIED TO ENTIRE PERIMETER OF FRAME).
- DOOR CAN ALSO BE INSTALLED WHEN WATER INFILTRATION RESISTANCE IS NOT REQUIRED (SINGLE ROW SELF-ADHESIVE CLOSED CELL FOAM TAPE TO BE APPLIED TO ENTIRE PERIMETER OF FRAME).
- ANCHORS SHALL BE AS LISTED, SPACED AS SHOWN ON DETAILS. ANCHORS EMBEDMENT TO BASE MATERIAL SHALL BE BEYOND WALL DRESSING
- ANCHORING OR LOADING CONDITIONS NOT SHOWN IN THESE DETAILS ARE NOT PART OF THIS APPROVAL.
- MATERIALS INCLUDING BUT NOT LIMITED TO STEEL/METAL SCREWS THAT COME INTO CONTACT WITH OTHER DISSIMILAR MATERIALS SHALL MEET THE REQUIREMENTS.
- METAL STRUCTURES AT HEAD/JAMBS NOT BY GENSTEEL DOOR CO. MUST SUPPORT LOADS IMPOSED BY DOOR SYSTEM AND TRANSFER THEM TO THE BUILDING STRUCTURE.
- 2XWOOD BUCKS AT HEAD/JAMBS BY OTHERS MUST BE ANCHORED PROPERLY TO TRANSFER LOADS TO THE STRUCTURE.
- A LOAD DURATION FACTOR IN ALLOWABLE STRESS IS USED IN DESIGN OF ANCHORS INTO WOOD ONLY
- DOOR PANEL: MIN. 20 GA. (.038") STEEL MIN. Fy = 42 KSI MIN & Fu = 53 KSI MIN. DOOR FRAME: MIN. 18 GA. (.048") STEEL MIN. Fy = 42 KSI MIN. & Fu = 53 KSI MIN.
- DOOR PANEL STAINLESS OPTION: 20 GA (.038") STAINLESS STEEL, TYPES 304 OR 316 GRADES. Fy = 42 KSI MIN. Fu = 53 KSI MIN. DOOR PANEL MEETING MIN. Fy= 42 KSI & Fu = 53 KSI OR BETTER MAY QUALIFY HAVING "MIL-CERTIFICATE" AS A VERIFICATION OF THE AVAILABLE MIN. YIELD STRENGTH.
- DOOR FRAME STAINLESS OPTION: 18 GA (.048") STAINLESS STEEL TYPES 304 OR 316 GRADES, Fy = 42 KSI MIN. & Fu = 53 KSI MIN. DOOR FRAME MEETING MIN Fy = 42 KSI & Fu = 53 KSI OR BETTER MAY QUALIFY HAVING "MIL-CERTIFICATE" AS A VERIFICATION OF THE AVAILABLE MIN. YIELD STRENGTH.
- ULTIMATE DESIGN LOAD OBTAINED FROM ASCE 7-10, MULTIPLY BY 0.6, SHALL BE LESS THAN OR EQUAL TO MAX. DESIGN LOAD IN THIS DOCUMENT.

EGRESS REQUIREMENTS TO BE REVIEWED BY BUILDING OFFICIAL.

ALL FRAME JOINTS AND CORNERS TO BE SEALED WITH SILICONE AT PERIMETER

TYPE A 5/16" DIA. ULTRACONS BY 'ELCO' (Fy=155 ksi Fu = 177 ksi) THRU EMA (EXISTING MASONRY ANCHOR) DIRECTLY INTO CONCRETE, fc'=3000 PSI MIN.

1-3/4" MIN. EMBED, 2 3/16" MIN. EDGE DISTANCE

5/16" DIA. ULTRACONS BY 'ELCO' (Fy=155 ksi Fu = 177 ksi) THRU EMA (EXISTING MASONRY ANCHOR) INTO WOOD. SG=0.55 MIN.

1 1/2" MIN, EMBED, 1 1/2" MIN, EDGE DISTANCE

TYPE B 3/8" DIA. HILTI SLEEVE ANCHOR

THRU EMA (EXISTING MASONRY ANCHOR) DIRECTLY INTO CONCRETE fc'=3000 PSI MIN. 1-1/4" MIN. EMBED. 3 1/4" MIN. EDGE DISTANCE

3/8" DIA. HILTI SLEEVE ANCHOR

THRU EMA (EXISTING MASONRY ANCHOR) DIRECTLY INTO GROUT FILLED CONCRETE BLOCK

1-1/4" MIN. EMBED, 3 1/2" MIN. EDGE DISTANCE

TYPE C 3/8" DIA. SLEEVE ANCHOR BY 'WEJ-IT'

> THRU EMA (EXISTING MASONRY ANCHOR) DIRECTLY INTO CONCRETE fc'=4000 PSI MIN. 2-3/8" MIN. EMBED, 2 3/8" MIN. EDGE DISTANCE

TYPE C1 3/8" DIA. SLEEVE ANCHOR BY 'WEJ-IT'

THRU EMA (EXISTING MASONRY ANCHOR) DIRECTLY INTO GROUT FILLED CONCRETE BLOCK fm'=3000 PSI MIN.

1 1/4" MIN. EMBED, 2 3/8" MIN. EDGE DISTANCE

3/8" DIA. SLEEVE ANCHOR BY 'POWERS'

THRU EMA (EXISTING MASONRY ANCHOR) DIRECTLY INTO CONCRETE fc'=3000 PSI MIN. 2 1/2" MIN. EMBED, 3 1/8" MIN. EDGE DISTANCE

TYPE D1 3/8" DIA. SLEEVE ANCHOR BY 'POWERS'

THRU EMA (EXISTING MASONRY ANCHOR) DIRECTLY INTO GROUT FILLED CONCRETE BLOCK fm'=3000 PSI MIN

2" MIN. EMBED, 3 1/8" MIN. EDGE DISTANCE

5/16" DIA. SMS OR MACHINE BOLTS (MIN. GRADE 2 CRS) OR ST/ST

THRU EMA (EXISTING MASONRY ANCHOR)

INTO METAL STRUCTURES (STEEL OR ALUMINUM 1/8" MIN. THICK.) STEEL: Fy = 36 KSI MIN.

ALUMINUM: 6063-T5 MIN.

(STEEL IN CONTACT WITH ALUMINUM TO BE PLATED OR PAINTED)

5/8" MIN. EDGE DISTANCE

WIRE ANCHOR (FA3030) (FY = 60 KSI.) MIN. 10" LG HEAD/JAMB TO BE GROUT FILLED (3000 PSI MIN.) 0.173 DIA. STEEL WIRE ANCHORS EMBED INTO **GROUT FILLED CONCRETE BLOCK** fm'=3000 PSI MIN.

TYPE H 3/8" POWERS WEDGE BOLT ANCHOR BY 'POWERS'

> THRU EMA (EXISTING MASONRY ANCHOR) DIRECTLY INTO CONCRETE fc'=3000 PSI MIN. 1 1/2" MIN. EMBED, 3 1/4" MIN. EDGE DISTANCE

TYPICAL ANCHORS @ THRESHOLD:

1/4" DIA. ULTRACON BY "ELCO" (Fy =155 ksi Fu = 177 ksi) DIRECTLY INTO CONCRETE fc'=3000 PSI MIN. 1-1/2" MIN. EMBED, 2-1/2" MIN. EDGE DISTANCE

1/4" DIA. TAPCON BY "ELCO" (Fy = 100 ksi Fu = 125 ksi)


DIRECTLY INTO CONCRETE fc'=3000 PSI MIN. 1-1/2" MIN. EMBED. 2-1/2" MIN. EDGE DISTANCE

TYPICAL ANCHOR @ FRAME JAMB BOTTOM CORNER:

1/4" OR 5/16" DIA. ULTRACON BY "ELCO" (Fy = 155 ksi Fu = 177 ksi) DIRECTLY INTO CONCRETE fc'=3000 PSI MIN. 1-1/2" MIN. EMBED, 2-1/2" MIN. EDGE DISTANCE

> PRODUCT REVISED as complying with the Florida Acceptance No 18-5/16. 16

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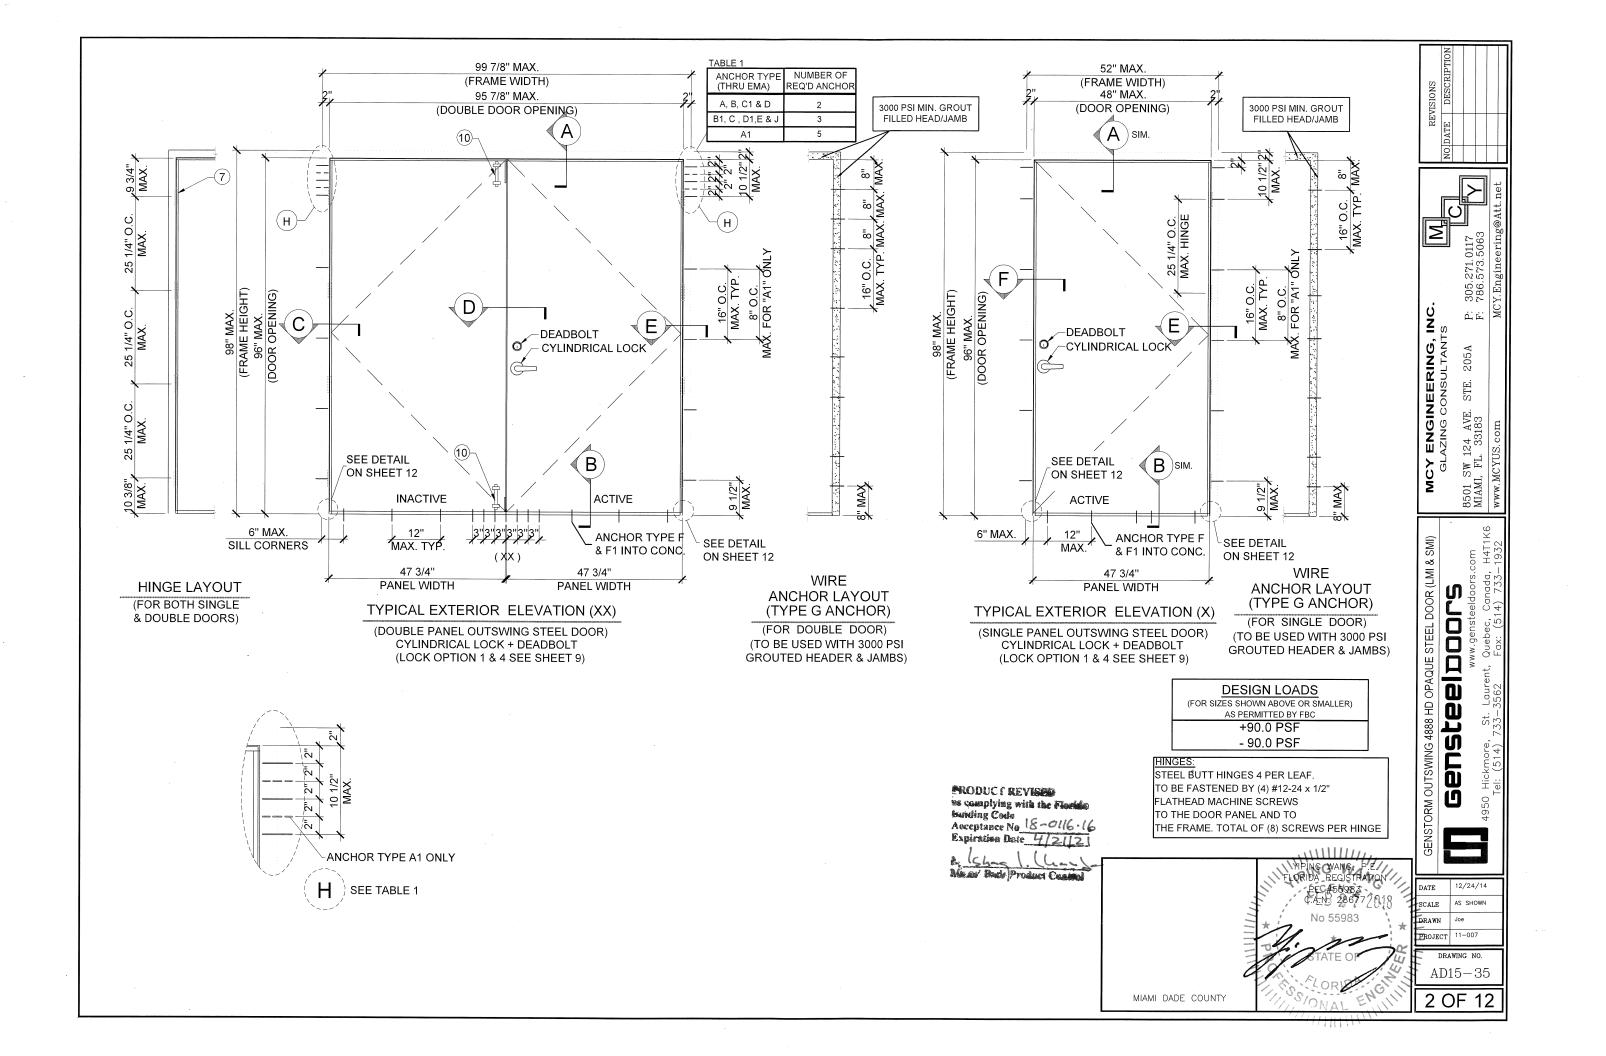
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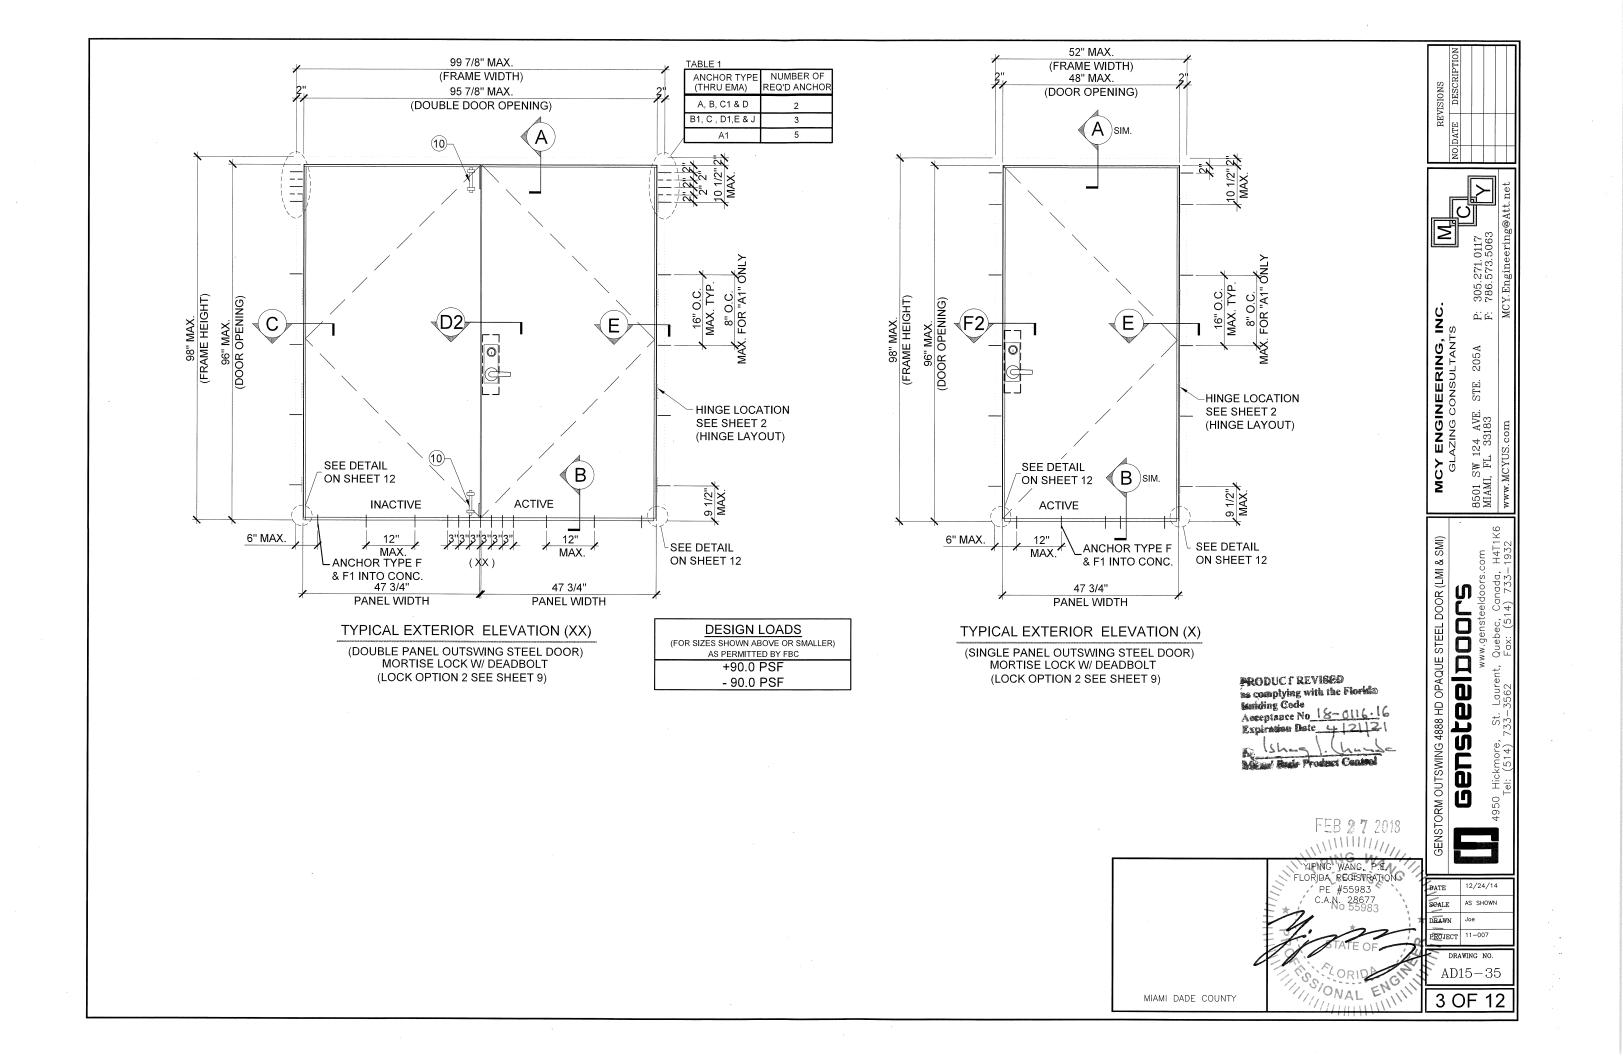
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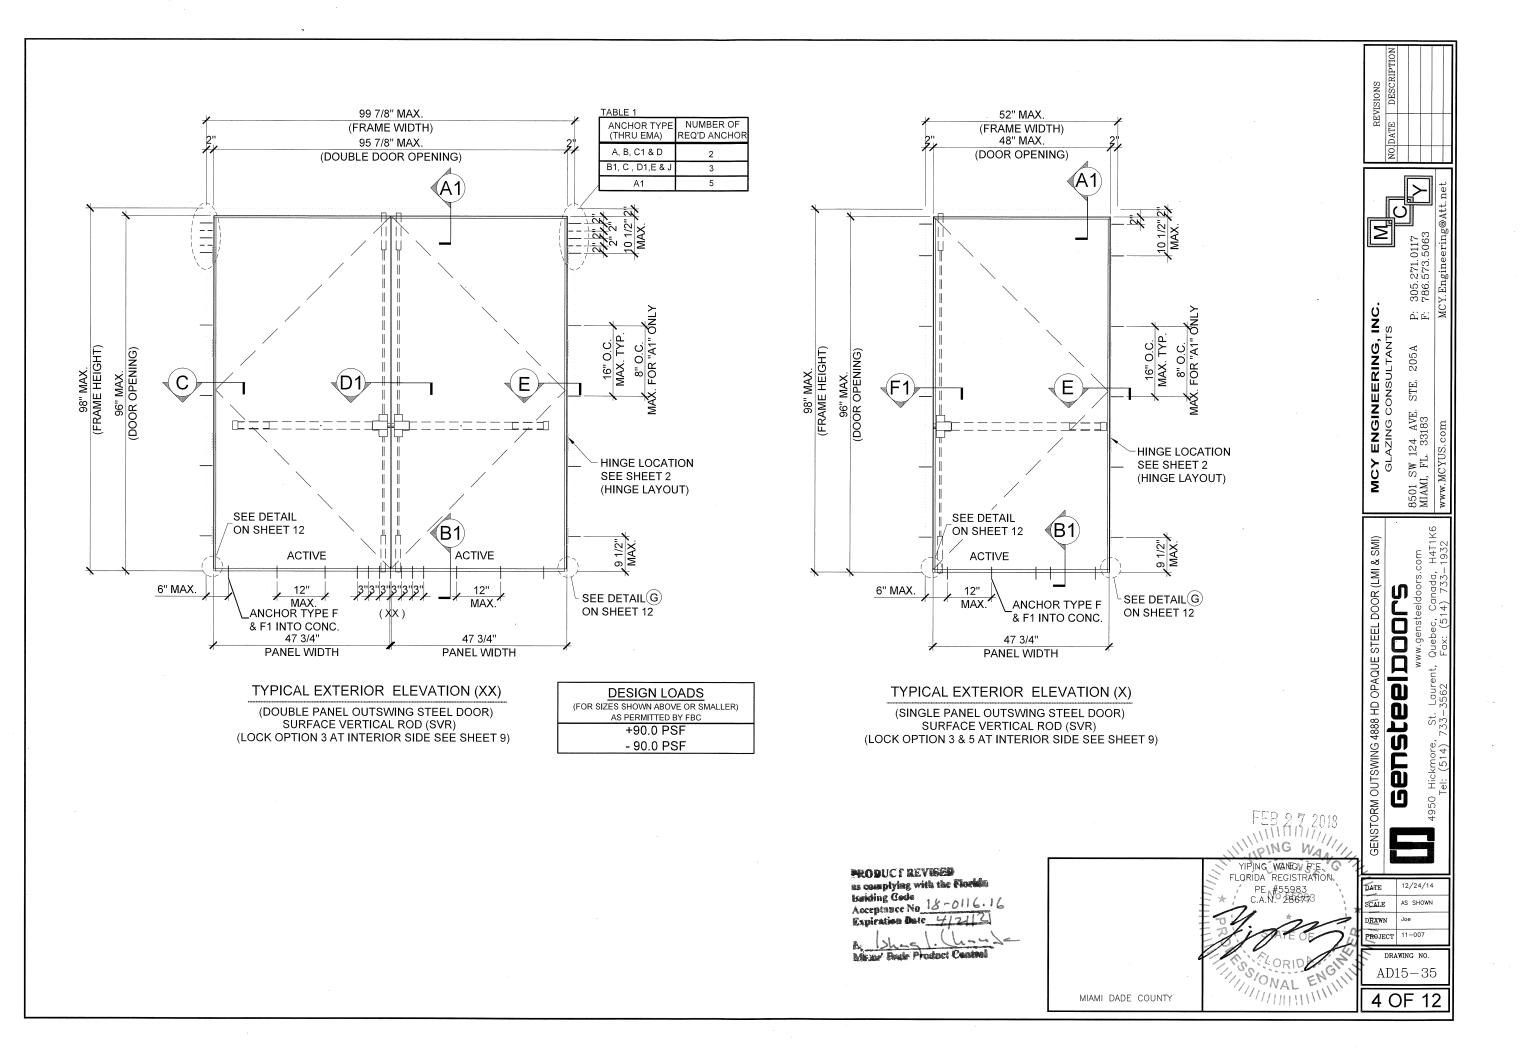
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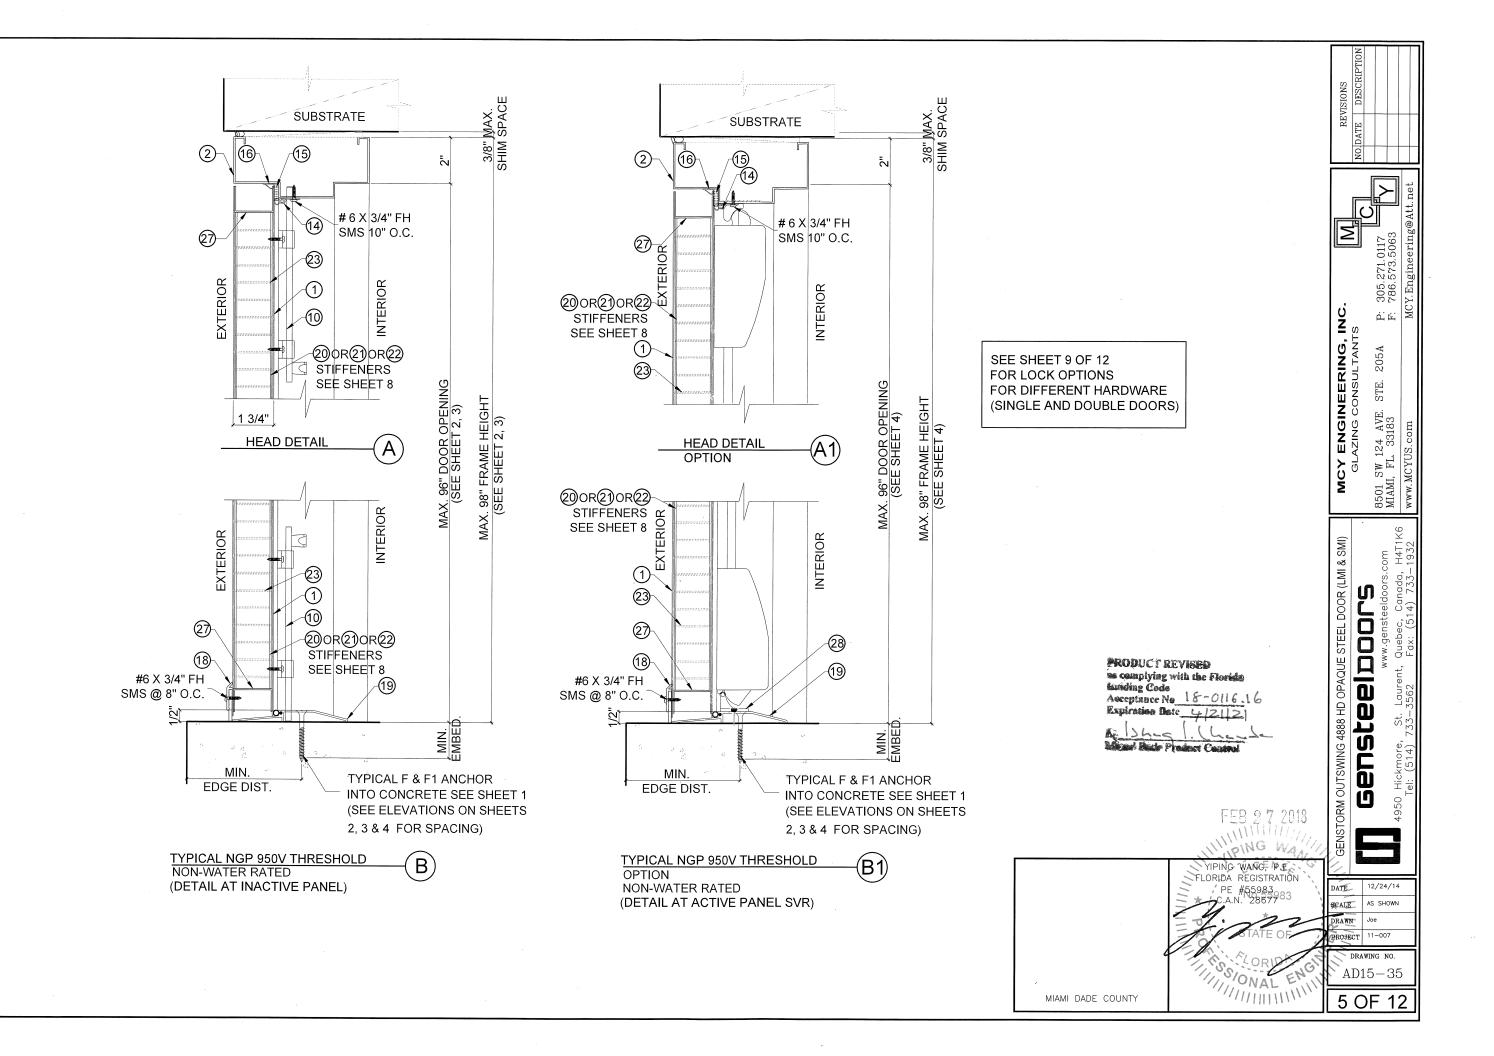
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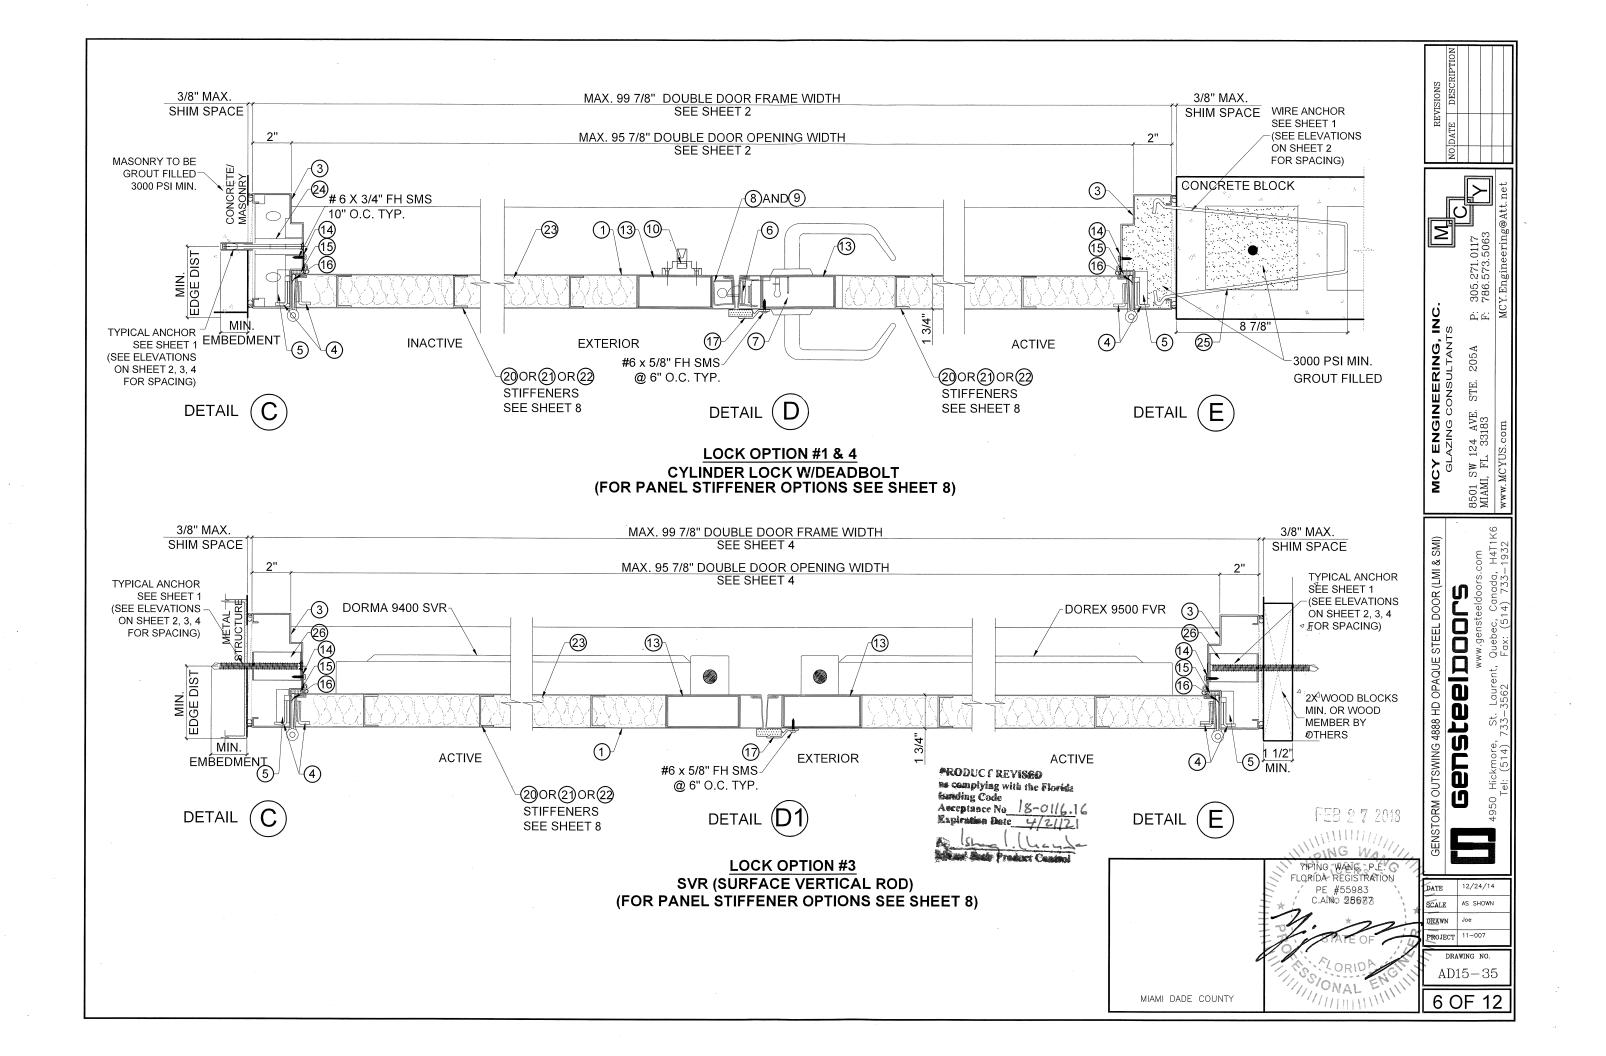
> AD15 - 351 OF 12

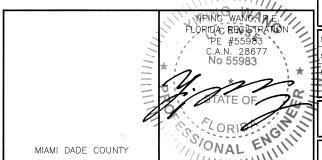












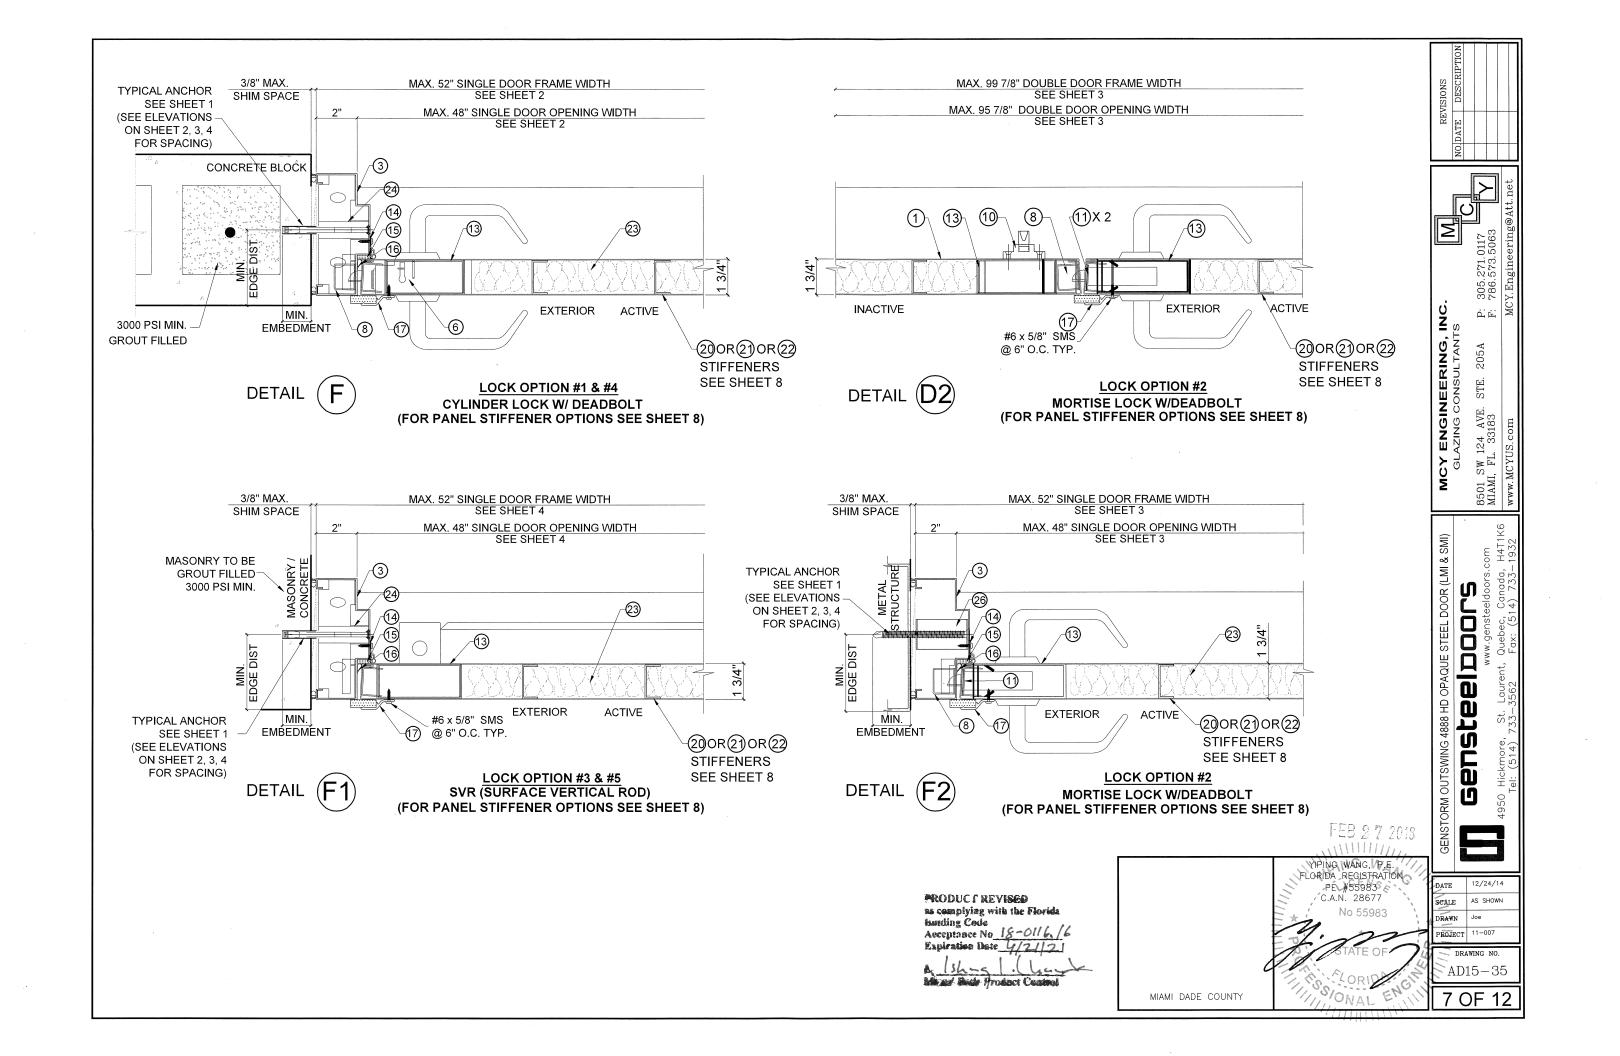

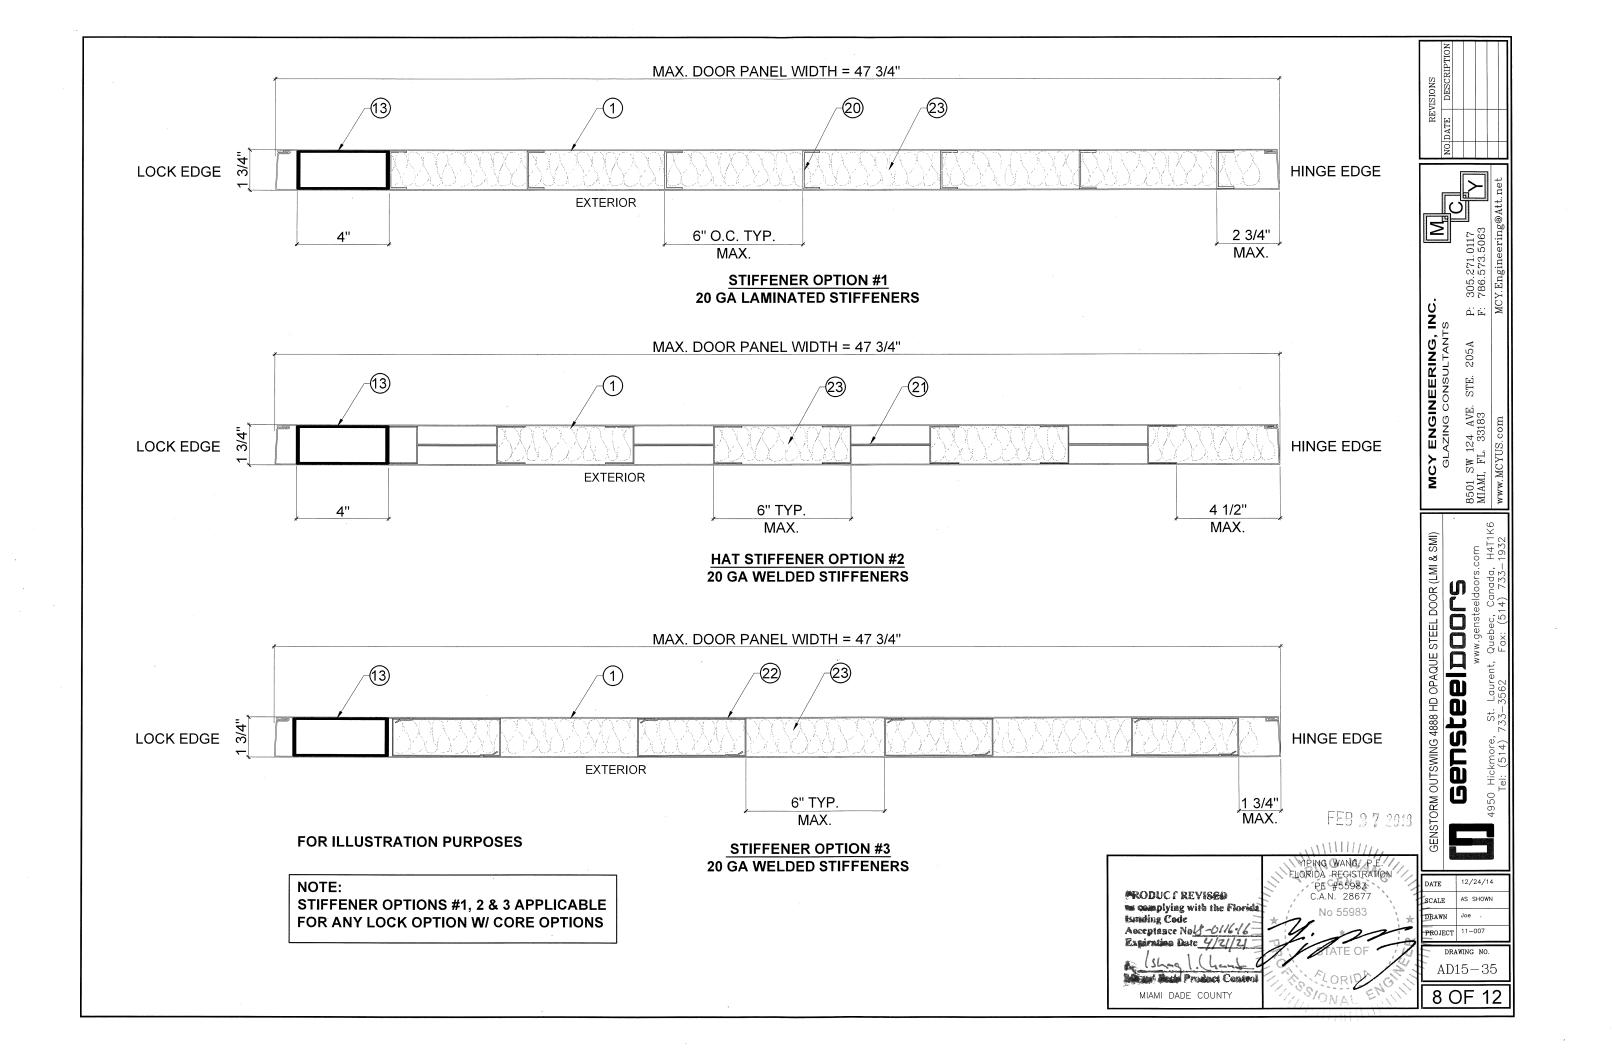

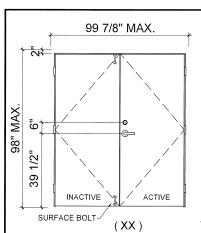

OPTION 1

DOUBLE DOOR

ACTIVE LEAF:

DOREX GX1L SURFACE MOUNT CYLINDER LOCK SET W/ (2) 12-24 X 2 5/8" FH MS AND (2) 8 X 1 1/4" FH MULTI THREAD SCREW, DOREX GX1A SURFACE MOUNT METALLIC DEADBOLT W/ (2) 10-32 X 1 1/2" OH MS AND (2) 8 X 3/4" FH MULTI THREAD SCREW

INACTIVE LEAF:

IVES SB360 SURFACE BOLT W/ (4) 10-24 X 1 1/4" OH MS (TOP & BOTTOM), (2) FLUSH MOUNT METALLIC STRIKE PLATE EACH W/ (2) 8 X 3/4" FH MULTI THREAD **SCREW**

99 7/8" MAX. 15 1/2"

INACTIVE

SURFACE BOLT-

ACTIVE

(XX)

OPTION 4

LOCK OPTIONS

EXTERIOR ELEVATIONS - OUTSWING DOORS

DOUBLE DOOR

ACTIVE LEAF:

INACTIVE LEAF:

OH MS

IVES SB360 SURFACE BOLT


DORMA CL700 CYLINDRICAL LOCKSET W/ (2) 8-32 X 1 3/8" PH MS AND (2) 8 X 3/4" FH MULTI THREAD SCREW DORMA DB660 MORTISE DEADBOLT W/ (2) 10-32 X 2 9/16" OH MS AND (2) 8 X 3/4" FH MULTI THREAD SCREW

(TOP & BOTTOM) W/ (4) 10-24 X 1 1/4"

DEADBOLT STRIKE PLATE W/ (2) 8 X

STRIKE PLATE W/ (2) 12 X 1" FH MULTI

3/4" FH MULTI THREAD SCREW

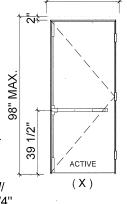

OPTION 4

OPTION 3

SINGLE DOOR

ACTIVE LEAF:

SINGLE DOOR

ACTIVE LEAF:

DORMA CL700 CYLINDRICAL LOCKSET W/ (2) 8-32 X 1 3/8" PH MS AND (2) 8 X 3/4" FH MULTI THREAD SCREW DORMA DB660 MORTISE DEADBOLT W/ (2) 10-32 X 2 9/16" OH MS AND (2) 8 X 3/4"

DOREX 9500 FV SERIES SURFACE MOUNT

RODS ON INTERIOR W/ (4) 10-24 X 1 1/4" OH

MS; (2) 10-24 X 1" PH SELF DRILLING MS;

(1) SURFACE MOUNT METALLIC STRIKE

(1) SURFACE MOUNT METALLIC STRIKE

PLATE (#9500A5227) AT FRAME HEAD


ATTACHED W/ (2) 10-24 X 3/4" FH MS;

PLATE (#9500A5233) AT THRESHOLD

ATTACHED W/ (2) 10 X 1" FH SMS

METALLIC 2 POINT LOCK SYSTEM W/

DEADBOLT STRIKE PLATE W/ (2) 8 X 3/4" FH MULTI THREAD SCREW STRIKE PLATE W/ (2) 12 X 1" FH MULTI

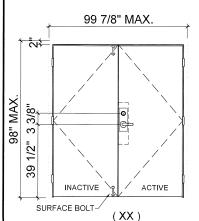

99 7/8" MAX.

ACTIVE

(XX)

2

39

ACTIVE

SURFACE BOLT-

OPTION 2


DOUBLE DOOR

ACTIVE LEAF:

DOREX DM45L MORTISE LOCK W/DEADBOLT SERIES LOCK SET W/ (2) 12 X 3/4" FH MULTI THREAD SCREW HANDLE W/ (2) #8-32 X 7/8" FH MS. KEY OPERATOR W/ (2) 10 X 3/4" FH SDS

INACTIVE LEAF:

IVES SB360 SURFACE BOLTS (TOP & BOTTOM) W/ (4) 10-24 X 1 1/4" OH MS STRIKE FOR LOCKSET W/ (2) 10 X 3/4" FH MULTI THREAD SCREW

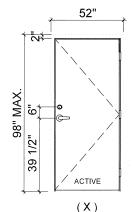

OPTION 3 DOUBLE DOOR

OPTION 3.1 ACTIVE LEAF/INACTIVE LEAF:

DOREX 9500 FV SERIES SURFACE MOUNT METALLIC 2 POINT LOCK SYSTEM W/ ACTIVATING PANIC DEVICE AND VERTICAL RODS ON INTERIOR W/ (4) 10-24 X 1 1/4" OH MS; (2) 10-24 X 1" PH SELF DRILLING MS;

- (1) SURFACE MOUNT METALLIC STRIKE PLATE (#9500A5227) AT FRAME HEAD ATTACHED W/ (2) 10-24 X 3/4" FH MS;
- (1) SURFACE MOUNT METALLIC STRIKE PLATE (#9500A5233) AT THRESHOLD ATTACHED W/ (2) 10 X 1" FH SMS

ACTIVE


OPTION 3.2

WITH SILICONE

ACTIVE LEAF/INACTIVE LEAF: STRIKE FOR LOCKSET.

DORMA 9400 SURFACE MOUNT METALLIC 2 POINT LOCK SYSTEM W/ ACTIVATING PANIC DEVICE AND VERTICAL RODS ON INTERIOR W/ (4) 12-24 X 1 1/2" FH MS; (2) 12-24 X 3/4" PH MS; (2) 12-24 X 3/4" OH MS AND SEX BOLT: (1) SURFACE MOUNT METALLIC STRIKE PLATE (#426) AT FRAME HEAD ATTACHED W/ (2) 12-14 X

3/4" OH MS; (1) SURFACE MOUNT METALLIC STRIKE PLATÉ (#439) AT THRESHOLD ATTACHED

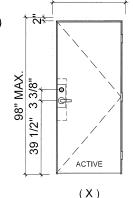

OPTION 1

SINGLE DOOR

THREAD SCREW

ACTIVE LEAF:

DOREX GX1L SURFACE MOUNT CYLINDER LOCK SET W/ (2) 12-24 X 2 5/8" FH MS AND (2) 8 X 1 1/4" FH MULTI THREAD SCREW. **DOREX GX1A SURFACE MOUNT** METALLIC DEADBOLT W/ (2) 10-32 X 1 1/2" OH MS AND (2) 8 X 3/4" FH MULTI THREAD **SCREW**

AT FRAME JAMB: (2) FLUSH MOUNT METALLIC STRIKE PLATE EACH W/ (2) 8 X 3/4" FH MULTI THREAD SCREW

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MAX 6"

OPTION 2


SINGLE DOOR

ACTIVE LEAF:

DOREX DM45L SERIES LOCK SET W/ (2) 12 X 3/4" FH MULTI THREAD SCREW HANDLE W/ (2) #8-32 X 7/8" FH MS, KEY OPERATOR W/ (2) 10 X 3/4" FH SDS.

AT FRAME JAMB:

(2) FLUSH MOUNT METALLIC STRIKE PLATE EACH W/ (2) 8 X 3/4" FH MULTI THREAD SCREW STRIKE FOR LOCKSET W/ (2) 10 X 3/4" FH MULTI THREAD SCREW

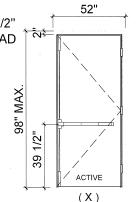

ACTIVE

(X)

FH MULTI THREAD SCREW

AT FRAME JAMB: THREAD SCREW


OPTION 5

SINGLE DOOR

ACTIVE LEAF:

DORMA 9400 SURFACE MOUNT METALLIC 2 POINT LOCK SYSTEM W/ **ACTIVATING PANIC DEVICE AND** VERTICAL RODS ON INTERIOR W/ (4) 12-24 X 1 1/2" FH MS; (4) 12-24 X 3/4" PH MS; (2) 12-24 X 3/4" OH MS AND SEX BOLT:

(1) SURFACE MOUNT METALLIC STRIKE PLATE (#426) AT FRAME HEAD ATTACHED W/ (2) 12-14 X 3/4" OH MS: (1) SURFACE MOUNT METALLIC STRIKE PLATE (#439) AT THRESHOLD ATTACHED WITH SILICONE

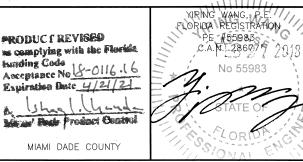











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ENGINEERING,
AZING CONSULTANT

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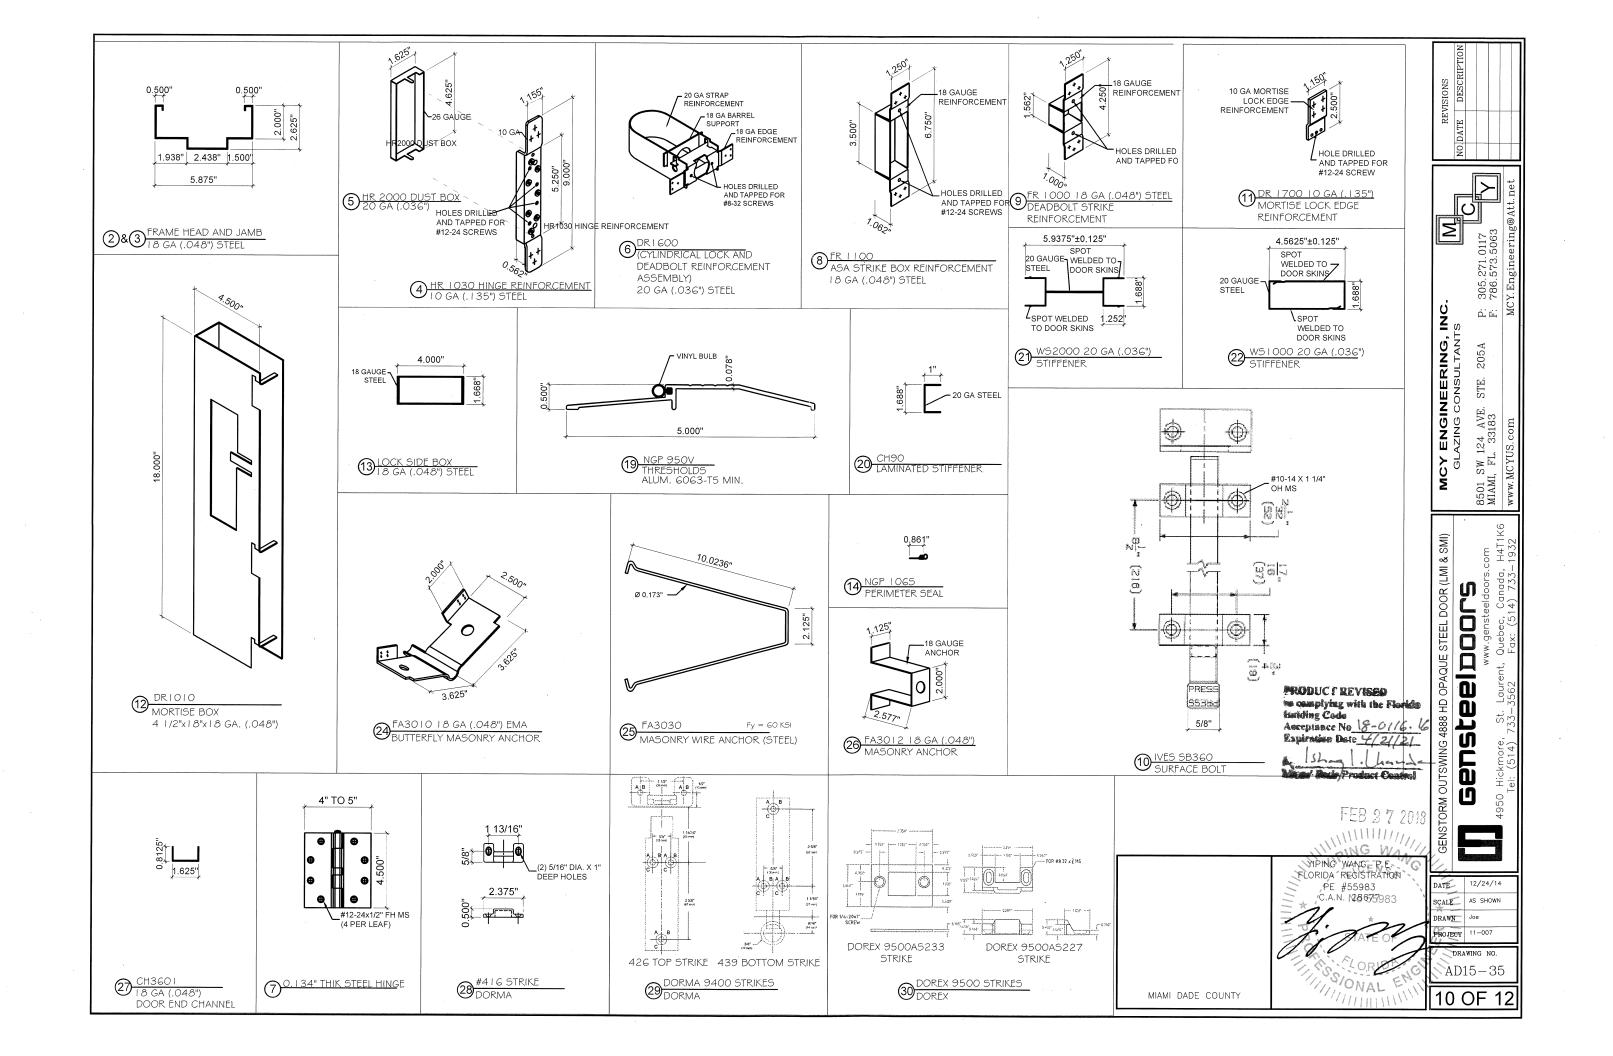
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sensteelboors

12/24/14 DATE AS SHOWN CALE RAWN ROJECT 11-007

AD15-35

9 OF 12



ITEM	BILL OF MATERIALS					
	PART NO.	MATERIAL	QTY.	DESCRIPTION	MANUFACTURER / SUPPLIER / REMARKS	REVISIONS E DESCRIPTION
1	••	STEEL OR ST/ST	2 PER PANEL	DOOR PANEL SKIN	GENSTEEL 20 GA. (0.038" MIN.) Fy=50 KSI MIN. Fu=53 KSI MIN.	REV
2	-	STEEL OR ST / ST	1	FRAME HEAD 5 7/8" X 2"	GENSTEEL 18 GA. (0.048" MIN.) Fy=50 KSI MIN. Fu=53 KSI MIN.	RI
3	-	STEEL OR ST/ST	2	FRAME JAMB 5 7/8" X 2"	GENSTEEL 18 GA. (0.048" MIN.) Fy=50 KSI MIN. Fu=53 KSI MIN.	NO
4	HR1030	STEEL	4 PER LEAF	HINGE REINFORCEMENT	GENSTEEL 10 GA. (0.135" MIN.), SPOT WELDED TO FRAME AND DOOR	
5	HR2000	STEEL	4 PER LEAF	HINGE DUST BOX	GENSTEEL 20 GA. (0.036" MIN.), SPOT WELDED	Att.net
6	DR1600	STEEL	AS REQD.	CYLINDRICAL LOCK AND DEADBOLT REINFORCEMENT ASSEMBLY	GENSTEEL 20 GA. (0.036" MIN.), SPOT WELDED	
7	HINGE	STEEL	4 PER LEAF	4 1/2" LONG HINGE	HAGER USA 0.134" MIN. THICKNESS	5.271.0117 86.573.5063 Engineering@At
8	FR1100	STEEL	AS REQD.	ASA STRIKE BOX	GENSTEEL, 18 GA (0.048" MIN.) W/ (2) 12 X 7/8" FH MULTITHREAD SCREWS	0117 5063
9	FR1000	STEEL	AS REQD.	DEAD BOLT STRIKE REINFORCEMENT	GENSTEEL, 18 GA (0.048" MIN.) W/ (2) 8 X 3/4" FH SHEET METAL SCREWS	271. 573. gine
10	VES SB360	STEEL	AS REQD.	SURFACE BOLTS AT INACTIVE PANEL	VES	305.2 786.5 Y.Eng
11	DR1700	STEEL	AS REQD.	MORTISE LOCK EDGE REINFORCEMENT WELDED	GENSTEEL 10 GA (0.135" MIN.), SPOT WELDED	
12	DR1010	STEEL	AS REQD.	MORTISE BOX REINFORCEMENT	GENSTEEL 18 GA (0.048" MIN.)	S S S S S S S S S S S S S S S S S S S
13		STEEL	AS REQD.	18 GAUGE LOCK SIDE BOX REINFORCEMENT FULL LENGTH	(AT ACTIVE/INACTIVE STILES) GENSTEEL 18 GA (0.048" MIN.)	T Y
14	NGP 106S	ALUMINUM	3	PERIMETER GASKET	NATIONAL GUARD PRODUCTS W/ #6 X 3/4" FH SMS 10" O.C.	ENGINEERING, AZING CONSULTANT 124 AVE. STE. 205A . 33183
15	NGP 362	NEOPRENE	-3	NEOPRENE TAPE	NATIONAL GUARD PRODUCTS	7 2 2 2 3
16	NGP 5050C	SILICONE	3	ADHESNE GASKET	NATIONAL GUARD PRODUCTS	DNS(
17	NGP 109NA	ALUMINUM	AS REQD.	MEETING ASTRAGAL	NATIONAL GUARD PRODUCTS W/#6 X 5/8" FH SMS 6" O.C.	Z O E
18	NGP 200NA	ALUMINUM	1 PER PANEL	DOOR BOTTOM SWEEP	NATIONAL GUARD PRODUCTS W/#6 X 3/4" FH SMS 8" O.C.	MCY ENGING C GLAZING C B501 SW 124 AVE. MIAMI, FL 33183 www.MCYUS.com
19	NGP 950V	ALUMINUM	1 PER PANEL	BUMPER THRESHOLD W/ VINYL BULB	NATIONAL GUARD PRODUCTS	AZ AZ 1124
20	CH90	STEEL	AS REQD.	20 GAUGE LAMINATED STIFFENERS	GENSTEEL 20 GA (0.036" MIN)	SW SIV
21	WS2000	STEEL	AS REQD.	20 GAUGE WELDED STIFFENERS (HAT SECTION)	GENSTEEL, 20 GA (0.036" MIN.) SPOT WELDED TO BOTH DOOR SKINS	MC ST AMI,
22	WS1000	STEEL	AS REQD.	20 GAUGE WELDED STIFFENERS	GENSTEEL, 20 GA (0.036" MIN.) SPOT WELDED TO BOTH DOOR SKINS	85 MI _v
	CORE (OPTION 1)	HONEYCOMB	AS REQD.	HONEYCOMB CORE INSIDE DOOR PANEL W/STIFFENERS	GENSTEEL	
	CORE (OPTION 2)	FIBERGLASS	AS REQD.	FIBERGLASS CORE INSIDE DOOR PANEL W/STIFFENERS	JOHNS MANVILLE	MI) 77 7 7 7 7 7 7 7 7 7 7 7 7 7 7 7 7 7
23	CORE (OPTION 3)	POLYURETHANE	AS REQD.	POLYURETHANE CORE INSIDE DOOR PANEL W/STIFFENERS	JOHNS MANVILLE	S S mo
	CORE (OPTION 4)	POLYSTYRENE	AS REQD.	POLYSTYRENE CORE INSIDE DOOR PANEL W/STIFFENERS	LEGERLITE	(LMI & SMI) Drs.com ida, H4T1P 33-1932
	CORE (OPTION 5)	ROCKWOOL	AS REQD.	ROCKWOOL CORE INSIDE DOOR PANEL W/STIFFENERS	ROXUL	OR ()
24	FA3010	STEEL	AS REQD.	BUTTERFLYMASONRYANCHOR	GENSTEEL	DOO DOO 114, Creel
25	FA3030	STEEL	AS REQD.	MASONRY WIRE ANCHOR 0.173" DIA.	GENSTEEL	TEEL Jens Jens
26	FA3012	STEEL	AS REQD.	MASONRY ANCHOR BRACKET	GENSTEEL	(A)
27	CH3601 416	STEEL STEEL	2 PER PANEL AS REQD.	13/16" X 1-5/8" X 13/16" X 18 GA DOOR END FULL WIDTH CHANNEL STRIKE PLATE	GENSTEEL 18 GA (0.048" MIN) PROGRESSION WELDED TO BOTH DOOR SKINS DORMA	OUE WW.
	26 (TOP), 439 (BOTTOM)	STEEL	AS REQD.	DORMA 9400 STRIKE PLATES	DORMA	OPAQUE 8 www. aurent, Q
30	9500AS223 (TOP), 9500AS227 (BOTTOM)	STEEL	AS REQD.	DOREX 9500 STRIKE PLATES	DOREX	TSWING 4888 HD C ETSE Hickmore, St. La 81: (514) 733-356


*RODUC! REVISED

ns complying with the Florida

banking Code

Acceptance No. 18-0/16.16


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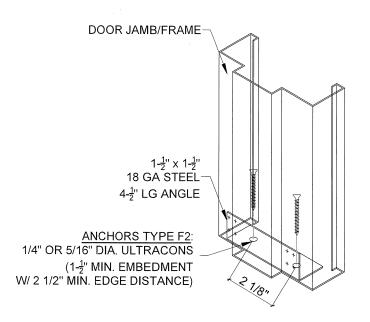
REVISIONS
NO DATE DESCRIPTION

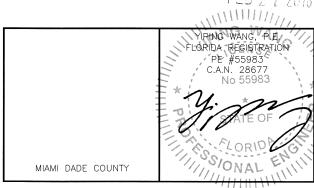12/24/14 SCALE DRAWN AS SHOWN PROJECT 11-007 DRAWING NO. AD15-35


11 OF 12



CORNER ASSEMBLY

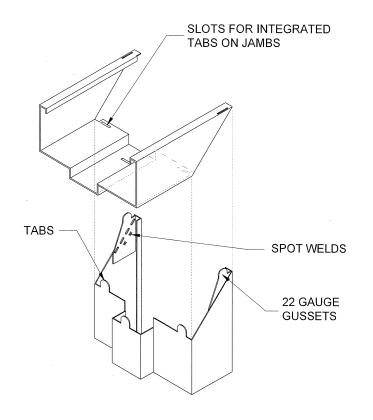

BOTTOM CORNER ANCHOR DETAIL OPTIONAL

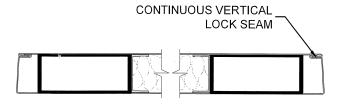


DOOR EDGE CONSTRUCTION FOR ILLUSTRATION PURPOSES

PRODUCT REVISED as complying with the Florida Acceptance No 1 X

FEB 27 2018

THE JAMB AND HEAD MEETING CORNERS ARE NOT REQUIRED TO BE WELDED TO EACH OTHER. ALL THE FRAMES WERE TESTED AS "KNOCK-DOWN" UNITS.

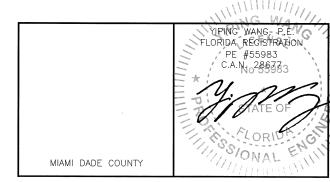

MCY ENGINEERING, INC. GLAZING CONSULTANTS ヴ표 205A STE. 8501 SW 124 AVE. MIAMI, FL. 33183 FORM OUTSWING 4888 HD OPAQUE STEEL DOOR (LMI & SMI) Gensteelboors

St. 733–

12/24/14 SCALE AS SHOWN DRAWN Joe AD15-35

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